


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REVISIONS				DDC. NO. SPC-F004 * Effective: 12/21/98 * DCP No: 680					
DCP #	REV	DESCRIPTION		DRAWN	DATE	CHECKD	DATE	APPRVD	DATE
811	A	Released		JWM	6/12/02	HO	6/13/02	DJC	6/13/02

NOTES:

1. Material: Nylon 6/6
2. Color: Natural

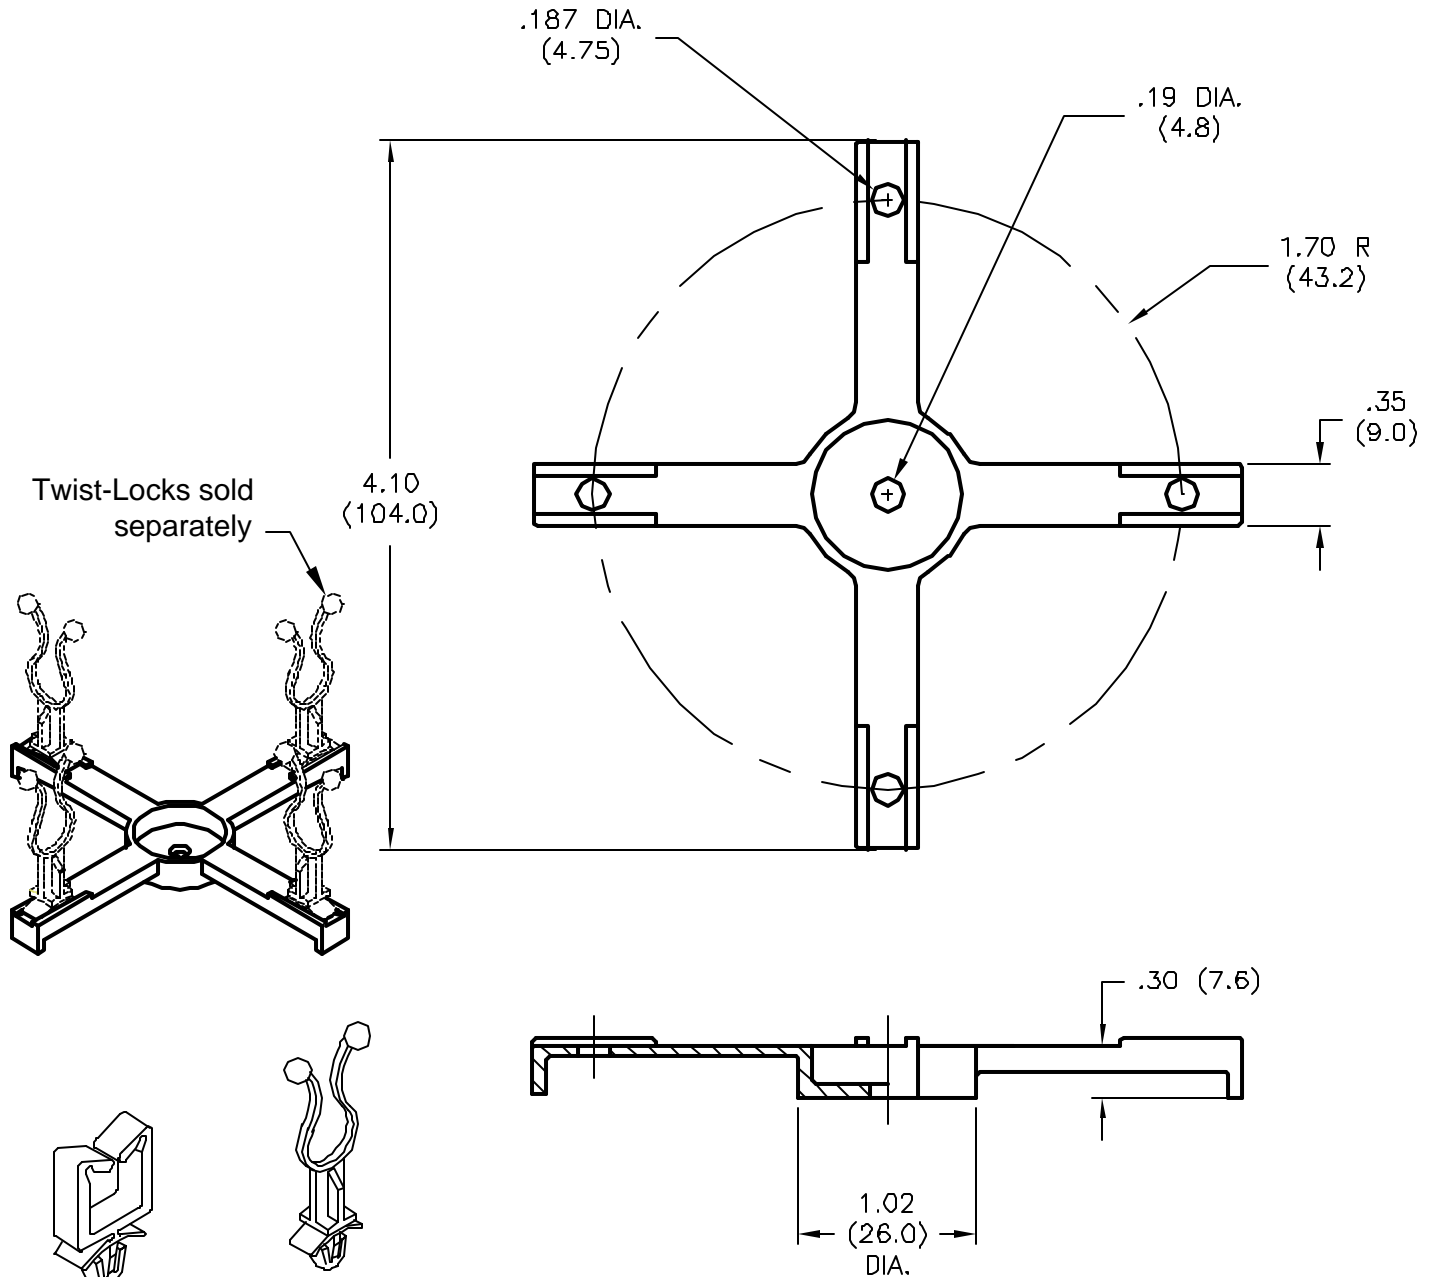

Wire Saddles & Twist-Locks
SOLD SEPARATELY

SPC-F004.DWG

DISCLAIMER:
ALL STATEMENTS AND TECHNICAL INFORMATION CONTAINED HEREIN ARE BASED UPON INFORMATION AND/OR TESTS WE BELIEVE TO BE ACCURATE AND RELIABLE. SINCE CONDITIONS OF USE ARE BEYOND OUR CONTROL, THE USER SHALL DETERMINE THE SUITABILITY OF THE PRODUCT FOR THE INTENDED USE AND ASSUME ALL RISK AND LIABILITY WHATSOEVER IN CONNECTION THEREWITH.



SPC TECHNOLOGY

DRAWING TITLE:
Optical Fiber Spider Base - Screw Mount

Tolerances Unless
Otherwise Specified:
.XX = ± 0.010 [0.25]
.XXX = ± 0.005 [0.13]
Frac. = $\pm 1/64$
Ang = $\pm 1^\circ$

DRAWN BY:	DATE:
Jeff McVicker	6/12/02
CHECKED BY:	DATE:
Hisham Odish	6/13/02
APPROVED BY:	DATE:
Daniel Carey	6/13/02

SIZE	DWG. NO.	ELECTRONIC FILE	REV
A	2571	92N4786.DWG	A
SCALE: NTS		U.O.M.: INCHES [mm]	SHEET: 1 OF 1